



REQUEST FOR TENDER No. 21-012

Church Road Transfer Station Residential Transfer Building Upgrade

Addendum 4

Issued: September 24, 2021

Total Pages: 5

Closing Date & Time: on or before 3:00 PM Pacific Time on September 29, 2021

This addendum shall be read in conjunction with and considered as an integral part of the Request for Tender. Revisions supersede the information contained in the original Tender or previously issued Addendum. No consideration will be allowed for any extras due to any Vendor not being familiar with the contents of this Addendum. All other terms and conditions remain the same.

Enclosed is Addendum 4 from the Project Engineer, Herold Engineering Ltd.

End of Addendum 4

Attn: Kurtis Felker
Regional District of Nanaimo
6300 Hammond Bay Road
Nanaimo BC V9T 6N2

DATE: September 24, 2021

PROJECT No.: 0837-068

PROJECT NAME:

CRTS - Phase 1: Ventilation System
860 Church Road, Parksville BC

From: Erich Streit, Arch HTL, Project Manager

3 Pages Following

ADDENDUM – 04

1. *This Addendum shall be read in conjunction with and considered as an integral part of the Contract Documents; revisions supersede the information contained in the original drawings, specifications or previously issued Addendum.*
2. *Tender Price submitted shall include all items of this Addendum.*
3. *No consideration will be allowed for any extras due to any bidder not being familiar with the contents of this Addendum.*

Addendum Information:

1. Electrical Addendum E2:
Refer to the attached electrical Addendum E2 issued by RB Engineering Ltd.
2. Mechanical Drawings:
Refer to updated mechanical drawings M-1 and M-2 with issued date of January 26 2021 attached to this Addendum.
3. Response to Bidder questions:
 - .1 The new wall mounted exhaust fans are located in the same position as existing – approximately 8' down from the top of the structure where located.
 - .2 The type of exhaust fan specified have their own integral starters. However, this may change depending on the actual fans that get submitted at shop drawing review, in which case supply fans may require separate starters.
 - .3 Existing roof above the Residential Transfer Building is of Standing Seam Metal
 - .4 Anticipated start of construction is October 25th and completion by end of February 2022

Per: Erich Streit, Arch HTL

CC: Kurtis Felker - RDN
Kevin Guizzetti / Ben Routledge - RDN
BC Bid & RDN Website
All Sub-Consultants

Electrical Addendum

Project: CRTS Ventilation System Upgrade Phase 1
Parksville, BC
19-3308

Addendum: E2

Date: September 24th, 2021

This Addendum forms part of the Contract Documents and is to be read, interpreted and coordinated with all other parts. The cost of all work contained herein shall be included in the Contract Sum. The following revisions supersede the information contained in the original drawings and specifications issued for the above named project to the extent referenced and shall become part thereof.

The following relates to the existing panels:

1. Panel 2A is Eaton Culter Hammer Pow-R-Line 1a. Panel 6A make and manufacturer is unknown.

The following relates to the starters for supply and exhaust fans:

1. Starters to be supplied and installed by electrical contractor.

SUB-CONSULTANT:

KEYPLAN:

No.	DATE	DESCRIPTION	BY
3	26JAN2021	ISSUED FOR TENDER	AM
2	21AUG2020	REVISED	AM
1	20DEC2019	COORDINATION	AM

REVISIONS:

NO. DATE DESCRIPTION BY

1 20DEC2019 COORDINATION AM

2 21AUG2020 REVISED AM

3 26JAN2021 ISSUED FOR TENDER AM

Copyright Reserved:
Everything shown hereon is for use on this project only and may not be reproduced without the written permission of ROCKY POINT ENGINEERING LTD. and unless the reproduction carries their name.

SEAL:

CLIENT:

PROJECT:
**CRTS - RESIDENTIAL
TRANSFER BUILDING
UPGRADES**
860 CHURCH ROAD
PARKVILLE, BC


DRAWING NAME:
FLOOR PLAN - MECHANICAL

PROJECT NUMBER:
19615-N

DRAWN BY: NG
DESIGNED BY: AM
APPROVED BY: AM
SCALE: 1/8" = 1'-0"

DRAWING:

M-1

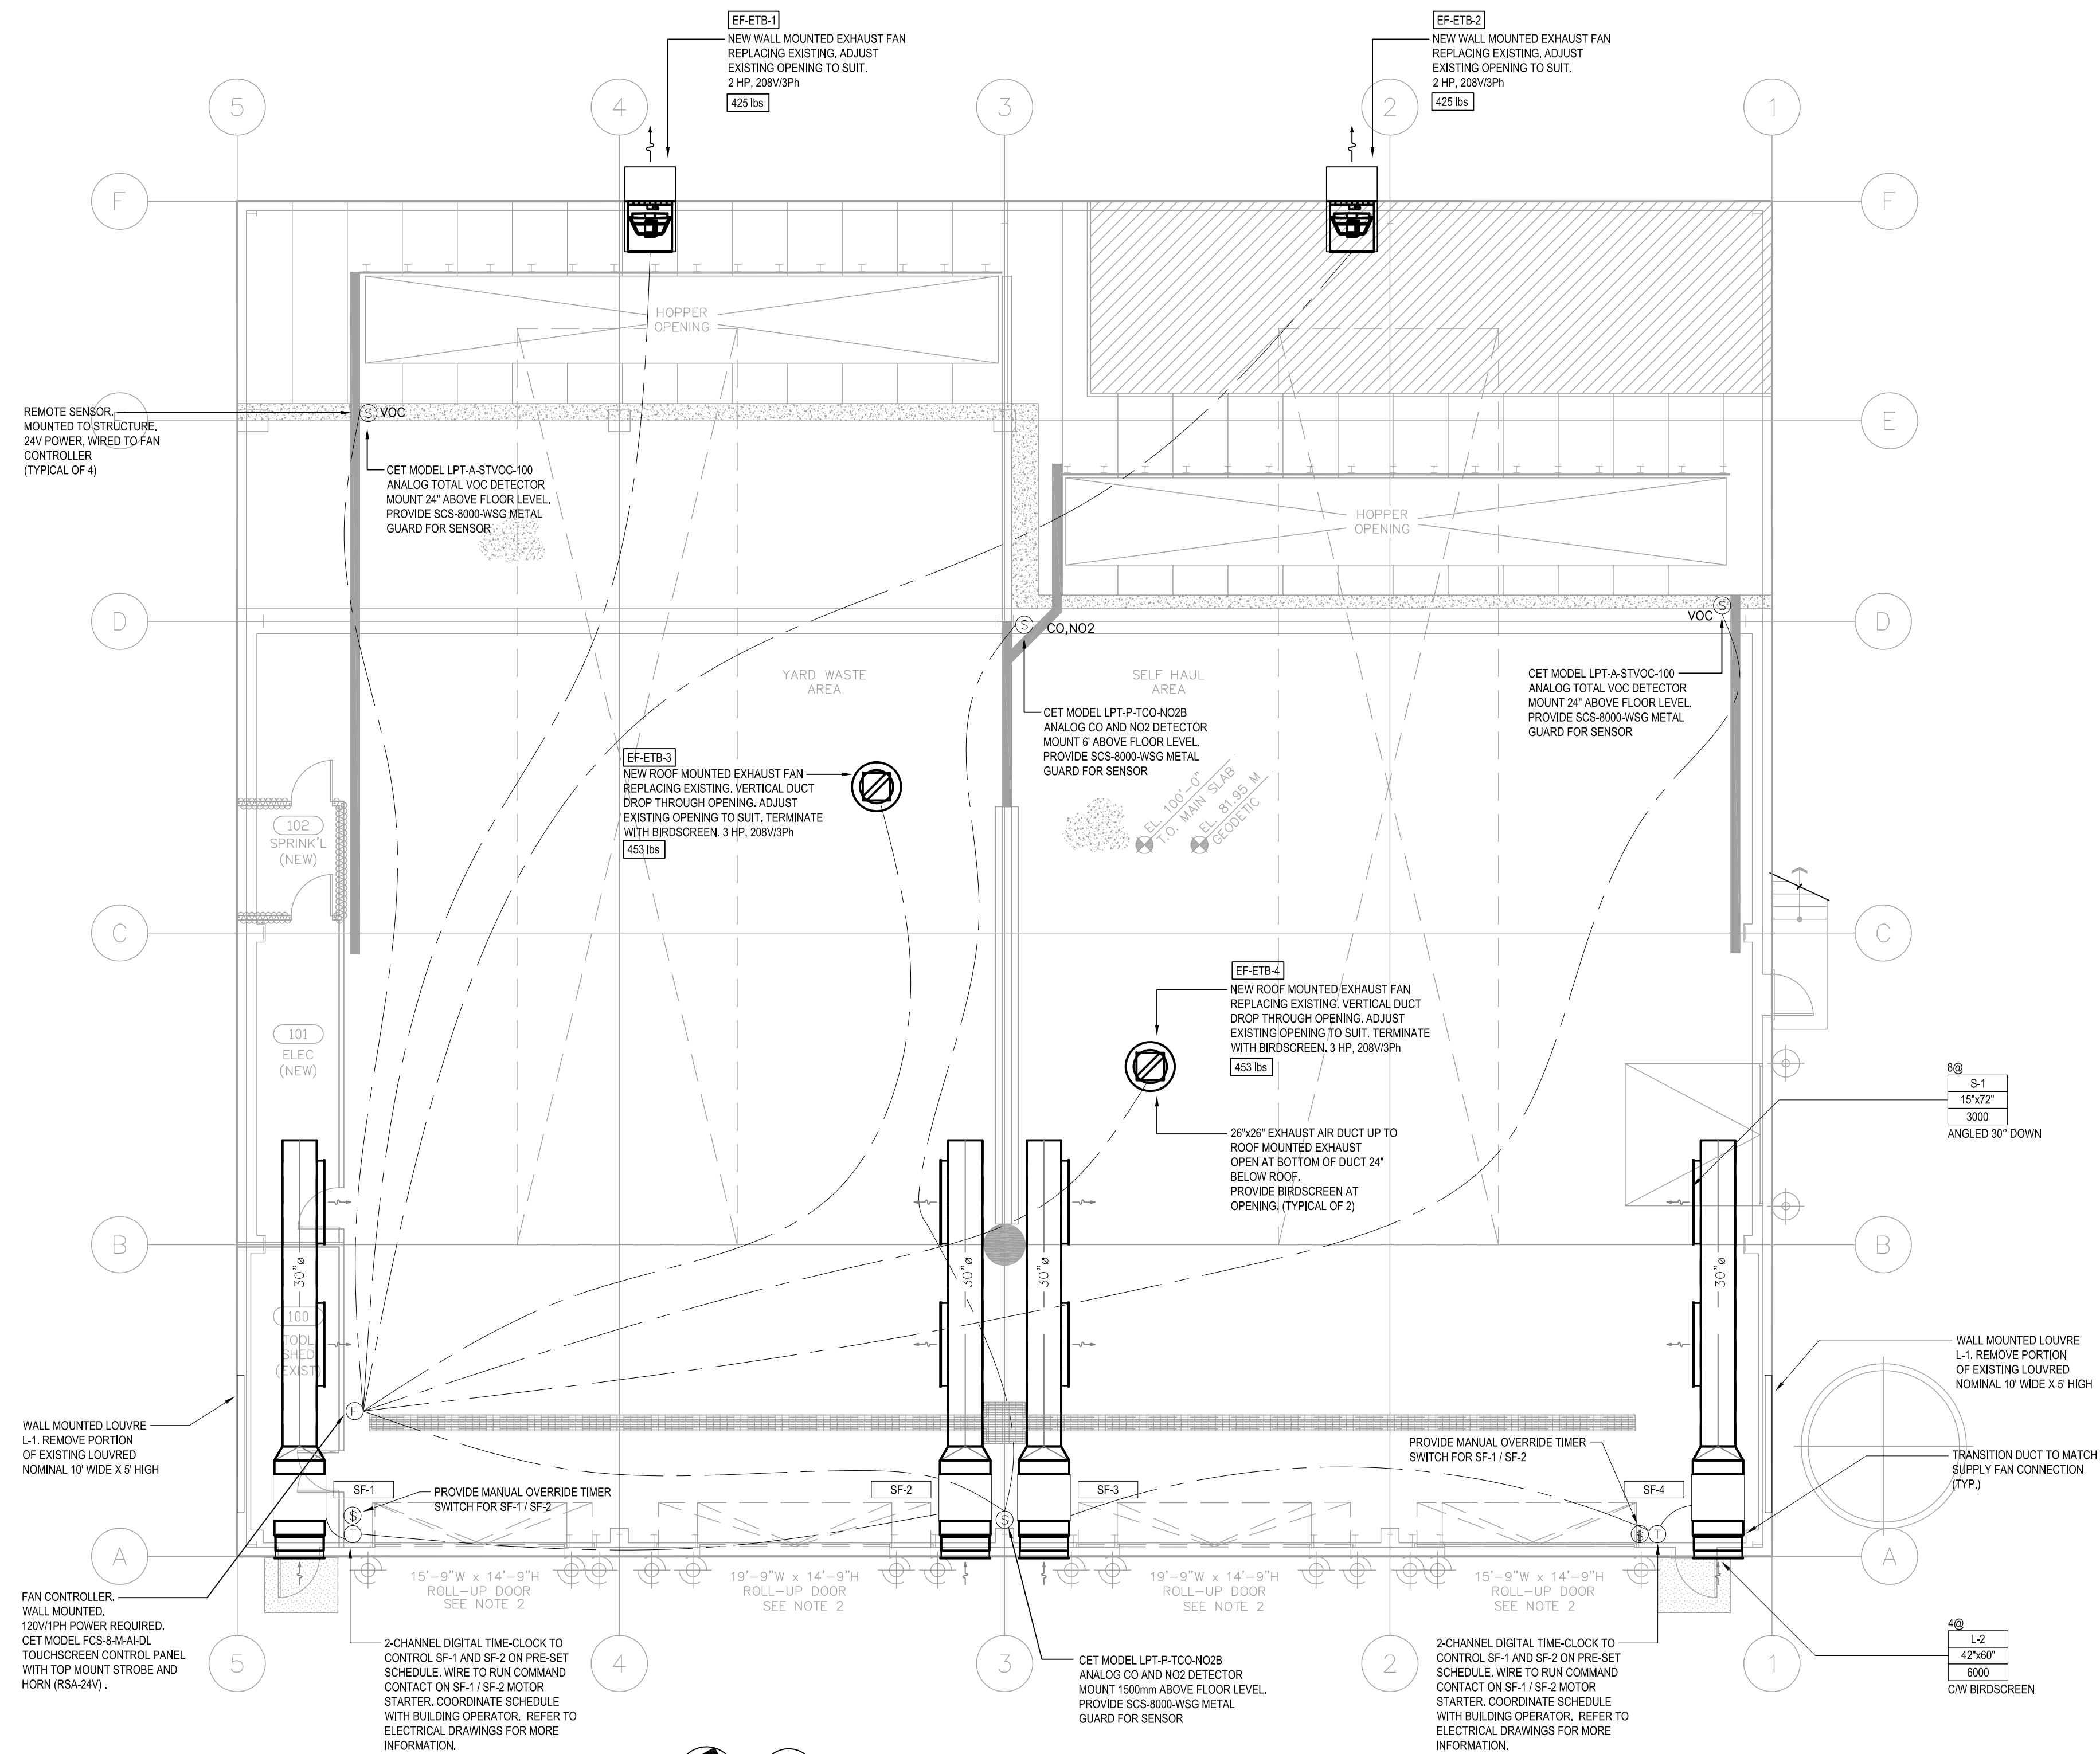

RESIDENTIAL TRANSFER BUILDING -- FLOOR PLAN MECHANICAL
SCALE: 1/8"=1'-0"

